


GENERAL NOTES

- 1) SEE SHEET A8.6 FOR ROOFING, AND TERRACE REQUIREMENTS.

SHEET NOTES


- ① PROVIDE 6" HIGH THRESHOLD SIM. TO PARAPET @ GATE.
- ② DOWN SPOUT 1" OFFSET FROM WALL FACE. PROVIDE DIVERTER AT BOTTOM & SPLASH BLOCK.
- ③ DOWN SPOUT 1" OFFSET FROM WALL FACE. TERMINATE 4" ABOVE TERRACE.
- ④ SEE SHEET A7.2 FOR RECORD LOUVER SIZES FOR ELEVATOR SHAFT.
- ⑤ CONDENSER MOUNTING STANCHIONS - SEE DETAIL #5 / A8.6. - S.S.D. S.M.D.
- ⑥ LOCATION FOR FUTURE SOLAR PANELS.
- ⑦ WINDSCREEN BRACES BELOW SEE DETAIL #16/A8.1 - S.S.D.
- ⑧ LOUVERS @ STAIRWELLS TO BE 2'-0"x2'-0" 

ROOM MATERIAL AND FINISH CODES

PLAN DETAIL

FLOOR/BASE- 1061
FINISH CODE
WALL FINISH- 603
CEILING FINISH
(SYMBOL SHOWN ON PLAN)

FLOOR/BASE	WALL FINISH/MANSOAT	CEILING FINISH
0 SPECIAL-SEE DETAIL	0 SPECIAL-SEE DETAIL	0 SPECIAL-SEE DETAIL
1 SPALD CONCRETE	1 CMU	1 CONCRETE
2 CONCRETE/RESIL	2 CONCRETE	2 CONCRETE
3 CONCRETE/RESIL	3 GYP. BD. PAINTED	3 GYP. BD. PAINTED
4 RESIL. TILE/RESIL	4 PLANKWOOD VENEER OVER GYP. BD.	4 12X12 ACQUIS TILE
5 RESIL. SHEET/INT. COMD. BASE	5 FABRIC MULLYER OVER GYP. BD.	5 12X12 ACQUIS TILE (INT.)
6 CORET/WOOD BASE	6 ARCHITECTURAL CONCRETE	6 5/8"X 2 1/2" ACQUIS TILE (INT.)
7 STONE TILE/GER. TILE	7 SANDARY PANE/OPP. BD.	7 400FS PLASTER
8 QUARRY TILE/GER. TILE	8 GER. TILE (OP.80)	8 EXPOSED STRUCTURE
9 WOOD/WOOD	9 CERAM. PLASTER /PAINT	9 CERAM. PLASTER /PAINT

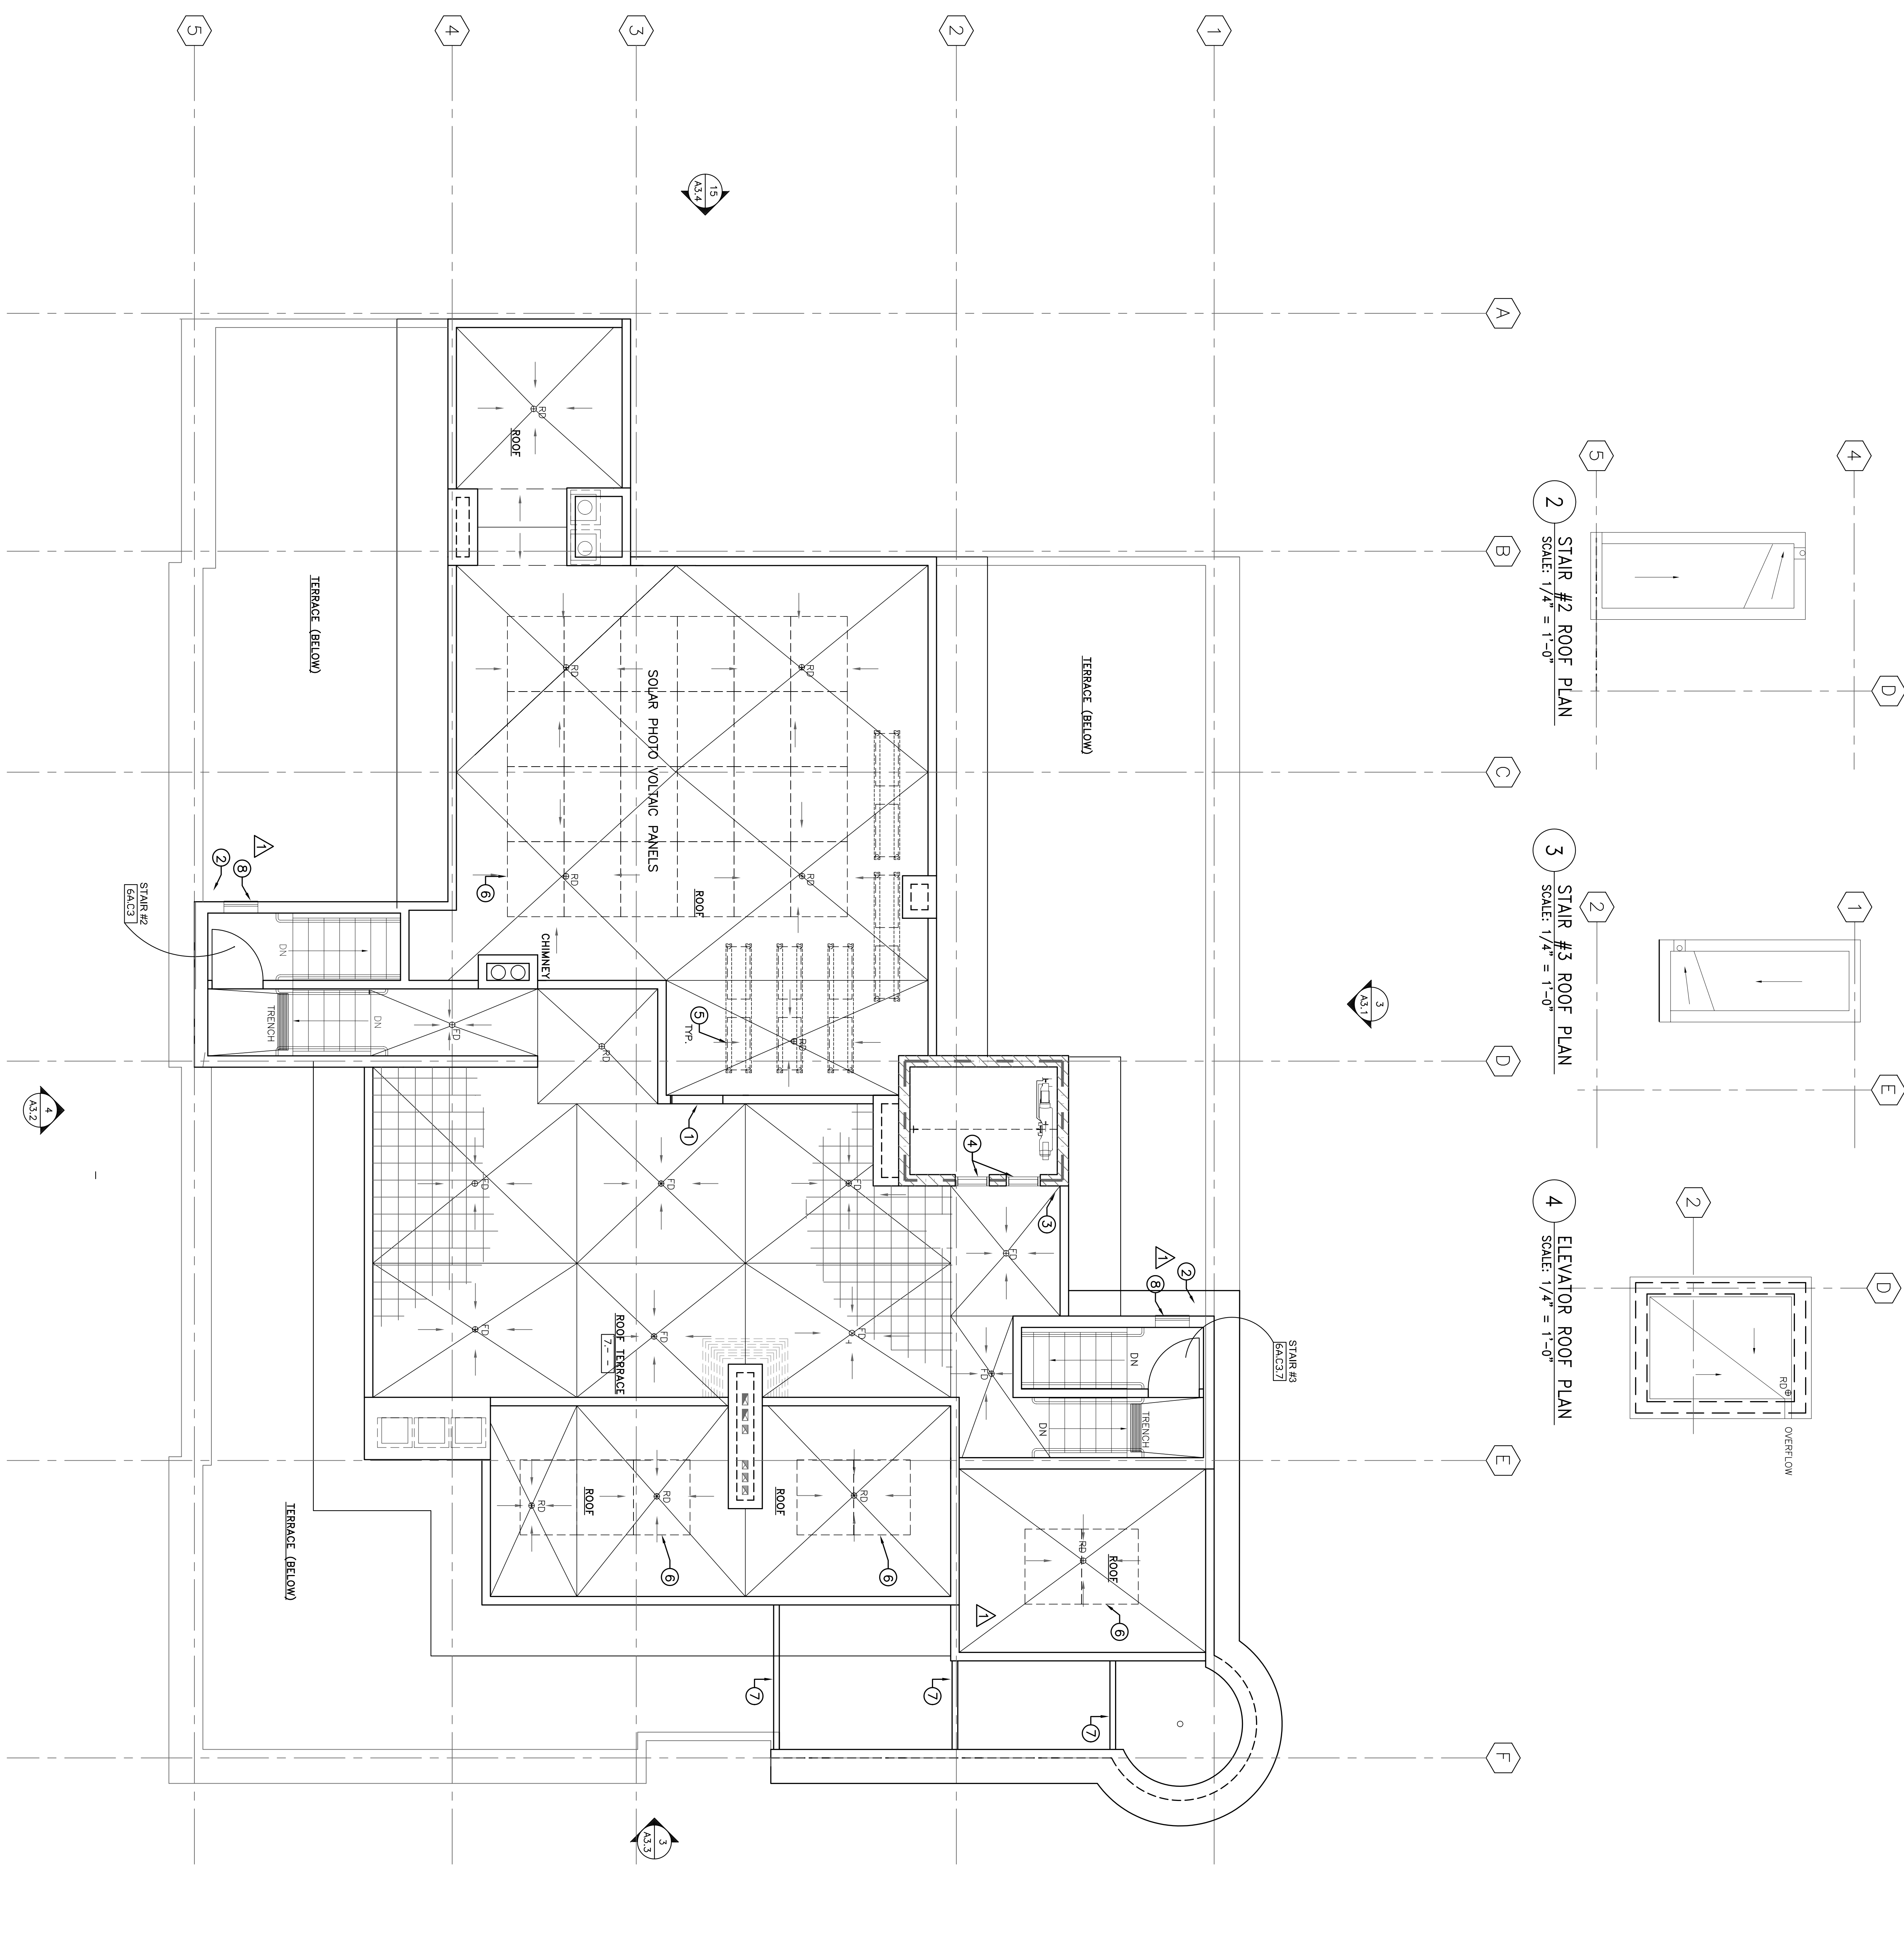

1 ROOF PLAN
SCALE: 1/4" = 1'-0"

REVISIONS
BR
AEC#1-1/12/06 RM

©MCE Architects, Inc. 2006

MEEKS, COATES + EATON ARCHITECTS, INC.
Architecture, Planning, Interior Design, Landscape Architecture
850 MONTGOMERY STREET, SUITE 300
SAN FRANCISCO, CALIFORNIA 94133
415.693.9234 415.693.9235 FAX

ROOF PLAN

VALLEJO STREET PROJECT
FOR LORENZO PETRONI
567 VALLEJO STREET
SAN FRANCISCO, CALIFORNIA
BLOCK: 0145
LOT NUMBERS: 27,35,36

DATE 09/19/05
SCALE AS NOTED
DRAWN BY TH/RM
SHEET
A2.5